


## Attachment A - Buffer Plan

### SYMBOL LEGEND

- WETLAND BUFFER AREA
- WOODLAND EDGE
- DELINEATED WETLAND
- WETLAND BUFFER MONUMENT 9' x 12" SIGN.  
SEE DETAIL FOR EXAMPLE.  
MONUMENT SHALL BE MOUNTED ON A WOODEN POST.  
SIGNS SHALL BE PLACED AS SHOWN WITH A  
SPACING NOT TO EXCEED 200'.  
WATERLINE
- BUFFER LIMITS

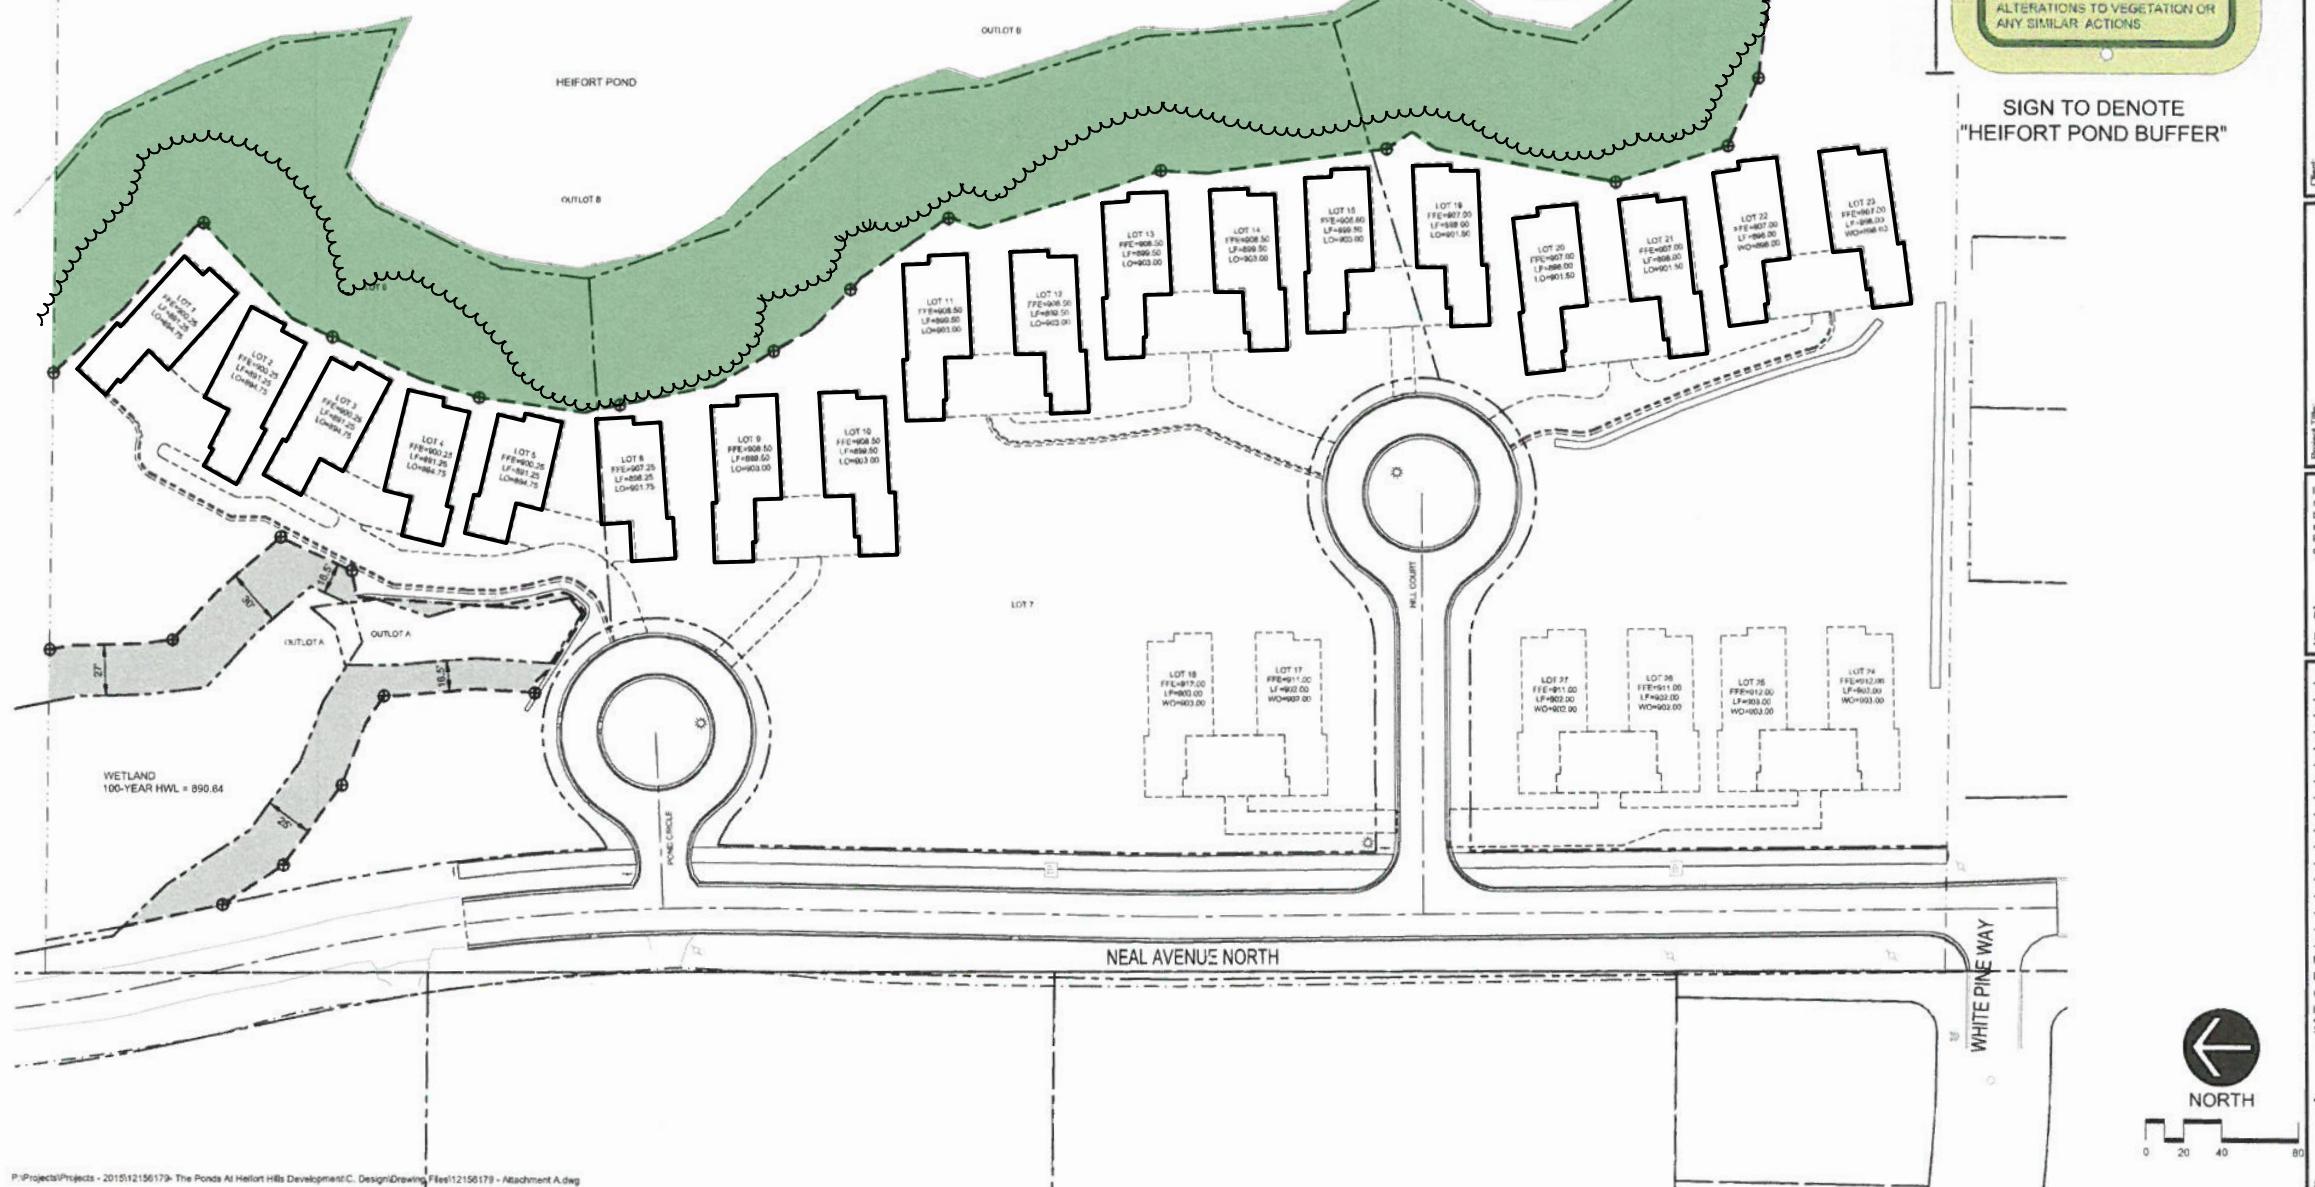

### GENERAL NOTES:

Official Buffer marked on plan above. This is the plan from the official recorded buffer declaration document.

Buffer setback is 75' from wetland edge in the year it was officially recorded. The wetland edge changes year to year, but the recorded buffer boundary stays the same. To re-establish buffer boundary today (on site), the setback would need to be surveyed wherever boundary markers may be missing. On average, home setbacks from the buffer boundary vary from about 4' to 6' at the closest points.

\*\*\* Green Buffer fill color and Woodland Edge linework added for illustrative purposes and was not included on recorded buffer drawing.

1 Recorded Buffer Drawing  
Scale: 1" = 100'-0"

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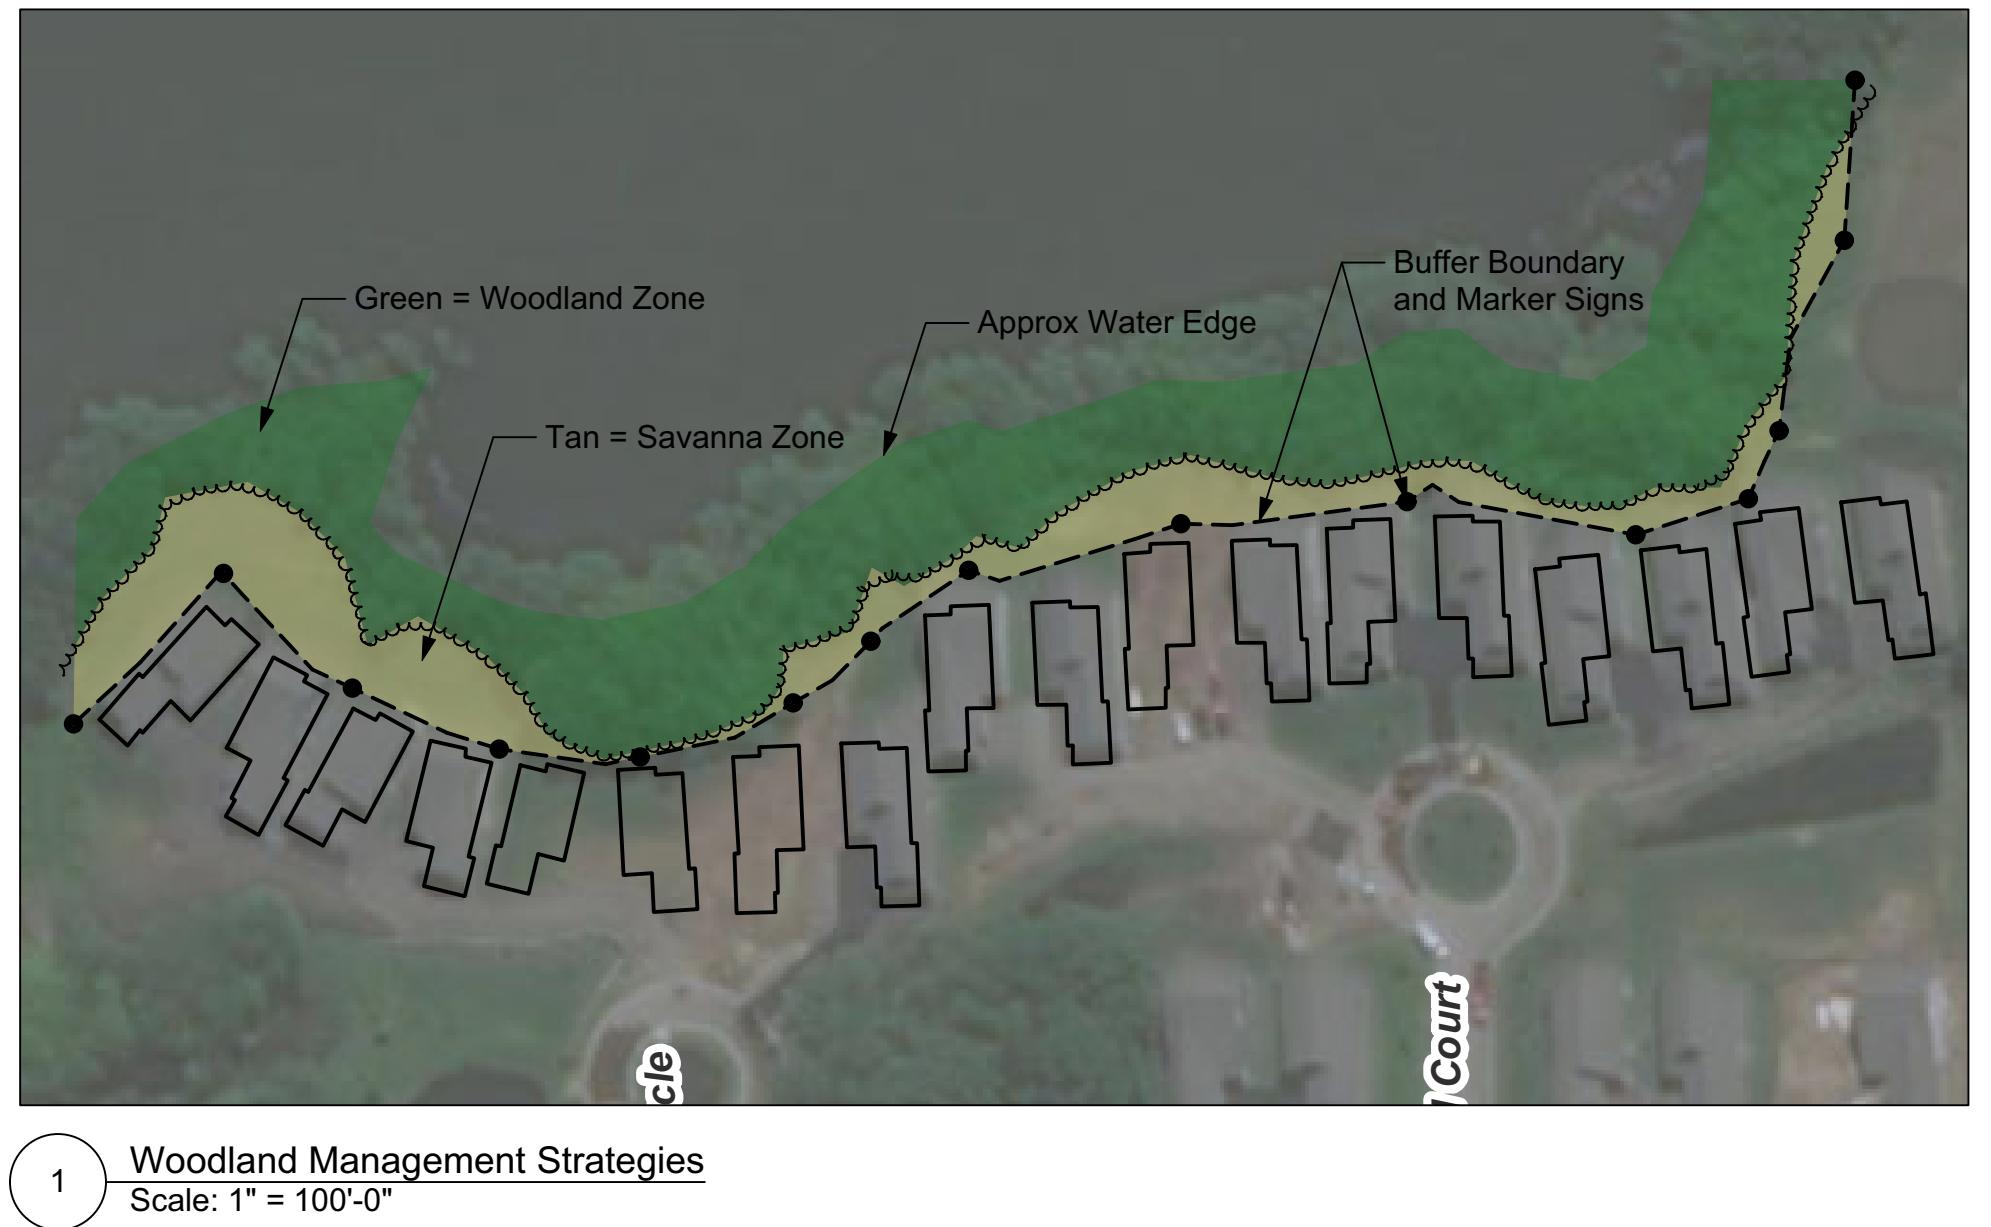
Plan created by:

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**GENERAL BUFFER NOTES:** Refer to Sections 4.4 through 4.8 of Attachment B of the official recorded Buffer Declaration. These sections outline the rules governing the buffer. Of note is 4.4.2(d), essentially stating that vegetative enhancements and trimming of trees are to be approved in writing by BWCD staff. All other vegetative alterations are prohibited within the buffer (such as mowing and clearing).

- \* Placement of non vegetative items such as firepits, wood piles, structures, pavers, fill materials, yard waste, and similar items are prohibited in the buffer zone. Bird feeders that are on temporary standards (not on permanent footings), and do not require clearing of vegetation are allowed.
- \* The buffer is property of the Heifort Hills Homeowner Association and pedestrian access points, path materials, and path alignments through the buffer must be coordinated and approved through the HOA and the Browns Creek Watershed District. Refer to guidelines in Section 4.8.2 of Attachment B of the official recorded Buffer Declaration.
- \* It is acceptable to remove species on the MN Dept of Agriculture 'Noxious Weed Lists'. <https://www.mda.state.mn.us/plants-insects/minnesota-noxious-weed-list> This includes Buckthorn. Follow DNR guidelines for proper Buckthorn control. Confer with BCWD and WCD staff for replacement or management strategies not mentioned in this document.
- \* Replace Buckthorn with species from the lists provided on the following pages.
- \* Only use native plants when planting replacement species in the buffer areas.

|   |   |
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|   |   |
| Plan created by:  |   |
| Project Address   | Heifort Hills HOA<br>Stillwater, MN 55082 |
| Project Manager   | Drawn<br>Reviewed<br>Revision             |
| Bryan Pynn  | Washington Conservation District          |
| <b>BROWN'S CREEK WATERSHED DISTRICT</b><br>455 Hayward Ave N - Oakdale, MN 55128<br><a href="http://www.bcwd.org">www.bcwd.org</a>                      |   |
| Project Title   | Heifort Hills Buffer Mgmt                 |
| Sheet Title   | Woodland Management Strategies            |
| CAD File Name   | Heifort Mgmt Plan.wix                     |
| Date  | 06/28/2021                                |
| <b>Sht-2</b><br>— of —<br>5   |   |

# WOODLAND ZONE:

Preferred species to be used in Woodland Zone.

## REPLACEMENT PLANTS FOR BUCKTHORN

Once you've removed invasive buckthorns & honeysuckles, & protected the existing native plants, consider the following native plants to fill the spaces.

| <b>SHRUBS</b>                  | <b>COMMON NAME</b>                  | <b>SUN REQUIREMENTS</b> |
|--------------------------------|-------------------------------------|-------------------------|
| <i>Amelanchier alnifolia</i>   | Saskatoon Serviceberry/Juneberry~   | Full sun to part shade  |
| <i>A. sanguinea</i>            | Round leaf serviceberry             | Full sun to part shade  |
| <i>Aronia melanocarpa</i>      | Black Chokeberry*                   | Full sun to part shade  |
| <i>Cornus sericea</i>          | Red-osier dogwood*                  | Full sun                |
| <i>C. racemosa</i>             | Gray dogwood~                       | Full sun to part shade  |
| <i>Corylus americana</i>       | Amer. Hazel                         | Full sun to part shade  |
| <i>Dierilla lonicera</i>       | Bush Honeysuckle/Bronzleaf Dierilla | Full sun to part shade  |
| <i>Dirca palustris</i>         | Leatherwood                         | Full shade to part sun  |
| <i>Euonymus atropurpureus</i>  | Eastern Wahoo~                      | Full sun to part shade  |
| <i>Hamamelis virginiana</i>    | Witchhazel                          | Full shade to part sun  |
| <i>Ilex verticillata</i>       | Winterberry*                        | Full sun (acidic soil)  |
| <i>Physocarpus opulifolius</i> | Common Ninebark                     | Full sun to light shade |
| <i>Prunus virginiana</i>       | Choke Cherry~                       | Full sun to part shade  |
| <i>Rhus glabra</i>             | Smooth Sumac~                       | Full Sun                |
| <i>R. typhina</i>              | Staghorn Sumac~                     | Full Sun                |
| <i>Rosa blanda</i>             | Early/meadow Wild Rose              | Full sun to part shade  |
| <i>R. palustris</i>            | Swamp Rose*                         | Full sun                |
| <i>Salix servicea</i>          | Red Willow*                         | Full sun                |
| <i>Salix discolor</i>          | Pussy Willow*                       | Full sun                |
| <i>Sambucus canadensis</i>     | Canada Elder*                       | Full sun                |
| <i>S. pubens</i>               | Red-berried elder                   | Full sun to shade       |
| <i>Staphylea trifolia</i>      | Bladdernut~                         | Full sun to part shade  |
| <i>Spiraea alba</i>            | Meadowsweet*                        | Full sun                |
| <i>Symphoricarpos albus</i>    | Snowberry                           | Full sun to shade       |
| <i>Viburnum lentago</i>        | Nannyberry~                         | Full sun                |
| <i>V. rafinesquianum</i>       | Downy Arrowwood                     | Full sun to open shade  |
| <i>V. trilobum</i>             | American High-bush Cranberry*       | Full sun to part shade  |
| <i>Alnus rugosa</i>            | Speckled Alder*                     | Full sun to part shade  |
| <b>Understory Trees</b>        |                                     |                         |
| <i>Amelanchier arborea</i>     | Downy serviceberry/Juneberry        | Full sun to part shade  |
| <i>A. laevis</i>               | Allegheny Serviceberry/Juneberry    | Full sun to part shade  |
| <i>Carpinus caroliniana</i>    | Blue Beech                          | Full shade to part sun  |
| <i>Cornus alternifolia</i>     | Pagoda dogwood                      | Full shade to sun       |
| <i>Crataegus spp.</i>          | Hawthorn                            | Full to part sun        |
| <i>Ostrya virginiana</i>       | Ironwood                            | Full shade to sun       |
| <i>Prunus americana</i>        | Wild Plum                           | Full sun to part shade  |
| <i>Prunus virginiana</i>       | Choke Cherry~                       | Full sun to part shade  |
| <i>Prunus pensylvanica</i>     | Pin Cherry~                         | Full sun to part shade  |
| <b>Trees</b>                   |                                     |                         |
| <i>Acer saccharum</i>          | Sugar Maple                         | Sun to full shade       |
| <i>Carya cordiformis</i>       | Bitternut Hickory                   | Sun to full shade       |
| <i>Prunus serotina</i>         | Black Cherry                        | Full sun to part shade  |
| <i>Tilia americana</i>         | American Basswood                   | Sun to full shade       |
| <i>Abies balsamifera</i>       | Balsam Fir (evergreen)              | Full shade to sun       |
| <i>Thuja occidentalis</i>      | Northern White Cedar (evergreen)    | Full sun to part shade  |

~ Plants that will form patches or thickets over time (excellent for wildlife areas, fencerows, or edged-hedges, but not where sprouts from roots are not wanted).

\* Plants well suited for moist soil.

Plants in bold are indigenous to oak and maple-basswood forest communities.

Read descriptions for these plants in the on-line catalog at [www.outbacknursery.com](http://www.outbacknursery.com)

This list prepared by Janet Van Sloun Larson

List originally provided by BCWD to Heifort Hills HOA for buffer re-establishment

| <b>HEIFORT HILLS SPECIES LIST</b>  |                        |            |        |            |     |
|--|------------------------|------------|--------|------------|-----|
| <b>GROUNDCOVER LAYER:</b>  |                        |            |        |            |     |
| Landscape plugs; Plant spacing @ 3' o.c. max throughout the entire buffer area   |                        |            |        |            |     |
| <b>SEDGES :</b>  |                        |            |        |            |     |
| (minimum 5 species)  |                        |            |        |            |     |
| <i>Carex bebbii</i>  | Bebb's Sedge           |            |        | medium-wet | wet |
| <i>Carex blanda</i>  | Common Wood Sedge      |            | medium | medium-wet | wet |
| <i>Carex brevior</i>   | Plains Oval Sedge      | medium-dry | medium | medium-wet |     |
| <i>Carex eburnea</i>   | Ivory Sedge            | medium-dry | medium | medium-wet |     |
| <i>Carex lacustris</i>   | Common Lake Sedge      |            |        | medium-wet | wet |
| <i>Carex muskingumensis</i>  | Palm Sedge             | medium-dry | medium | medium-wet |     |
| <i>Carex Sprengelii</i>  | Sprengel's Sedge       |            | medium | medium-wet |     |
| <i>Carex pennsylvanica</i>   | Pennsylvania Sedge     |            |        | medium-wet | wet |
| <i>Carex vulpinoidea</i>   | Fox Sedge              |            | medium | medium-wet |     |
| <b>GRASSES &amp; RUSHES:</b>   |                        |            |        |            |     |
| (minimum 5 species)  |                        |            |        |            |     |
| <i>Bromus ciliatus</i>   | Fringed Brome          |            |        | medium-wet | wet |
| <i>Bromus kalmii</i>   | Prairie Brome          | medium-dry | medium | medium-wet |     |
| <i>Calamagrostis canadensis</i>  | Blue Joint Grass       |            | medium | medium-wet | wet |
| <i>Chasmanthium latifolium</i>   | River Oats             |            | medium | medium-wet |     |
| <i>Elymus ciliatus</i>   |                        |            | medium | medium-wet | wet |
| <i>Elymus hystrix</i>  | Bottlebrush Grass      |            | medium |            |     |
| <i>Glyceria striata</i>  | Fowl Manna Grass       |            | medium | medium-wet | wet |
| <i>Juncus canadensis</i>   | Canada Rush            | medium-dry | medium | medium-wet |     |
| <i>Juncus effusus</i>  | Common Rush            |            |        | medium-wet | wet |
| <i>Panicum virgatum</i>  | Switch Grass           | medium-dry | medium | medium-wet |     |
| <i>Scirpus atrovirens</i>  | Dark-Green Bulrush     |            |        | medium-wet | wet |
| <b>WILDFLOWER LAYER:</b>   |                        |            |        |            |     |
| Landscape Plugs; plant in the spaces between groundcover plants; Plant spacing @ 3' o.c. max throughout entire buffer area |                        |            |        |            |     |
| (minimum 11 species)   |                        |            |        |            |     |
| <i>Agastache foeniculum</i>  | Anise Hyssop           | medium-dry | medium |            |     |
| <i>Asclepias incarnata</i>   | Swamp Milkweed         |            | medium | medium-wet | wet |
| <i>Campanula americana</i>   | Tall Bellflower        | medium-dry | medium | medium-wet |     |
| <i>Chamaenerion angustifolium</i>  | Fireweed               | medium-dry | medium | medium-wet |     |
| <i>Asarum canadense</i>  | Canadian Wild Ginger   |            |        |            |     |
| <i>Cimicifuga racemosa</i>   | Black Cohosh           |            | medium | medium-wet |     |
| <i>Conoclinium coelestinum</i>   | Mistflower             |            |        |            |     |
| <i>Eurybia macrophylla</i>   | Big - leaved Aster     | medium-dry | medium | medium-wet |     |
| <i>Eupatorium perfoliatum</i>  | Boneset                |            |        | medium-wet | wet |
| <i>Eutrochium purpureum</i>  | Sweet Joe-Pye Weed     | medium-dry | medium | medium-wet |     |
| <i>Gaura longiflora</i>  | Large-Flowered Gaura   | medium-dry | medium | medium-wet |     |
| <i>Helenium autumnale</i>  | Sneezeweed             |            |        | medium-wet | wet |
| <i>Lobelia siphilitica</i>   | Great Blue Lobelia     |            | medium | medium-wet | wet |
| <i>Monarda fistulosa</i>   | Wild Bergamot          | medium-dry | medium | medium-wet |     |
| <i>Aquilegia canadensis</i>  | Eastern Red Columbine  |            | medium | medium-wet |     |
| <i>Penstemon digitalis</i>   | Foxglove Beardtongue   | medium-dry | medium |            |     |
| <i>Physostegia virginiana</i>  | Obedient Plant         |            | medium | medium-wet | wet |
| <i>Rudbeckia laciniata</i>   | Wild Golden Glow       |            | medium | medium-wet |     |
| <i>Solidago flexicaulis</i>  | Zig Zag Goldenrod      | medium-dry | medium | medium-wet |     |
| <i>Sympyotrichum drummondii</i>  | Drummond's Aster       | medium-dry | medium | medium-wet |     |
| <i>Sympyotrichum oolentangiense</i>  | Sky Blue Aster         | medium-dry | medium |            |     |
| <i>Zizia aurea</i>   | Golden Alexanders      | medium-dry | medium | medium-wet |     |
| <b>SHRUBS:</b>   |                        |            |        |            |     |
| #1 min; can be larger size pots if desired; plant in spaces between groundcover plants; protect from deer                  |                        |            |        |            |     |
| ** Deep Shade tolerant species; other varieties are partial shade species  |                        |            |        |            |     |
| (minimum 6 species)  |                        |            |        |            |     |
| <i>Alnus incana subsp. rugosa</i>  | Speckled Alder         |            |        | medium-wet | wet |
| <i>Aronia melanocarpa</i>  | Black Chokeberry       |            |        |            |     |
| <i>Cornus alternifolia</i>   | Pagoda Dogwood**       |            | medium | medium-wet | wet |
| <i>Ilex verticillata</i>   | Winterberry Holly**    |            | medium | medium-wet | wet |
| <i>Sambucus canadensis</i>   | White Elderberry**     | medium-dry | medium | medium-wet |     |
| <i>Sambucus racemosa</i>   | Red Elderberry**       | medium-dry | medium | medium-wet |     |
| <i>Staphylea trifolia</i>  | Bladdernut**           |            |        |            |     |
| <i>Symporicarpos albus</i>   | Snowberry**            | medium-dry | medium |            |     |
| <i>Viburnum trilobum</i>   | American Cranberrybush |            | medium | medium     | wet |

|                               |          |  |  |
|-------------------------------|----------|--|--|
| Project Title                 |          | Heifort Hills Buffer Mgmt                                  |  |
| Sheet Title                   |          | WOODLAND ZONE - SPECIES LISTS                              |  |
| Project Manager               |          | Bryan Lynn Washington Conservation District                |  |
| Drawn                         | Reviewed | Revision   |  |
| Project Address               |          | Heifort Hills HOA Stillwater, MN 55082                     |  |
| Project File Name             |          | Heifort Mgmt Plan.wks                                      |  |
| Date                          |          | 06/28/2021   |  |
| CAD File Name                 |          | www.bcwd.org   |  |
| BROWN'S CREEK DISTRICT        |          | 455 Hayward Ave N - Oakdale, MN 55128 (651) 330-8220 xt 26 |  |
| WOODLAND ZONE - SPECIES LISTS |          | www.bcwd.org   |  |
| Sht-3                         |          | of 5   |  |



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# BWSR Pilot Seed Mixes

July 5, 2018

## PILOT SEED MIXES:

These new "Pilot" seed mixes have been developed for a variety of restoration, conservation and stormwater uses. Goals were to meet the needs of common project types and to create direction for emerging topics such as biofuels, buffers, conservation grazing, and pollinators. All of the mixes were developed for specific functions and incorporate pollinator habitat to the extent possible. The mixes will remain as pilot mixes for a couple years until we understand how they are performing before we work to make them official state mixes. In many cases these mixes should be considered starting points for developing site specific mixes.

Note: Oats cover crop is included as a component of these seed mixes with the exception of some wetland mixes where cover species are not necessary. Winter wheat (at a similar rate to oats) may be selected in some cases where germination is needed later in the fall, followed by further green-up the following spring (oats will not come back the follow spring unless it re-establishes from seed).

Finalized

## Little Bluestem Urban Prairie

|       | Function:               | Conservation                | Intent:         | Little bluestem dry prairie for urban areas where the planting mix needs to be simple for aesthetic purposes and to decrease maintenance |                 |               |  |
|-------|-------------------------|-----------------------------|-----------------|--|-----------------|---------------|--|
|       | Planting Area:          | Statewide                   | Specialization: |  |                 |               |  |
| Cover | Scientific Name         | Common Name                 | Seeds/sq ft     | Rate (lb/ac)   | % Mix (by sqft) | % Mix (by wt) |  |
|       | Avena sativa            | Oats* (See Cover crop note) | 11.13           | 37.88  |                 |               |  |
|       |                         | Total Guild:                | 11.13           | 37.88  | 16.57%          | 84.4%         |  |
| Forb  |                         |                             |                 |  |                 |               |  |
|       | Asclepias tuberosa      | Butterfly Milkweed          | 0.1             | 0.06   |                 |               |  |
|       | Asclepias verticillata  | Whorled Milkweed            | 0.05            | 0.01   |                 |               |  |
|       | Liatris aspera          | Rough Blazing Star          | 0.25            | 0.04   |                 |               |  |
|       | Penstemon grandiflorus  | Large-flowered Beard Tongue | 0.32            | 0.06   |                 |               |  |
|       | Rudbeckia hirta         | Black-eyed Susan            | 10.32           | 0.31   |                 |               |  |
|       | Solidago nemoralis      | Gray Goldenrod              | 2               | 0.02   |                 |               |  |
|       | Solidago ptarmicoides   | Upland White Aster          | 1.26            | 0.05   |                 |               |  |
|       | Sympyotrichum ericoides | Heath Aster                 | 2.58            | 0.04   |                 |               |  |
|       | Sympyotrichum laeve     | Smooth Aster                | 0.8             | 0.04   |                 |               |  |
|       | Tradescantia bracteata  | Bracted Spiderwort          | 0.6             | 0.16   |                 |               |  |
|       | Verbena stricta         | Hoary Vervain               | 1.2             | 0.12   |                 |               |  |
|       | Zizia aptera            | Heart-leaved Alexanders     | 0.2             | 0.05   |                 |               |  |

## SAVANNA ZONE:

Preferred species to be used in full sun spots, in Savanna Zones. This is where trees are mostly absent to being with. Can pick and choose species as preferred, but make sure to provide some balance between warm season and cool season species.


Some woodland species may migrate to this zone, depending on light and soil moisture. This is ok if they are native species.

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| Project Address | Heifort Hills HOA<br>Stillwater, MN 55082      |
| Project Manager | Bryan Pynn<br>Washington Conservation District |



|               |                             |
|---------------|-----------------------------|
| Project Title | Heifort Hills Buffer Mgmt   |
| Sheet Title   | SAVANNA ZONE - SPECIES LIST |
| CAD File Name | Heifort Mgmt Plan.wks       |

|      |            |
|------|------------|
| Date | 06/28/2021 |
| Page | Sht-4      |
| of   | 5          |
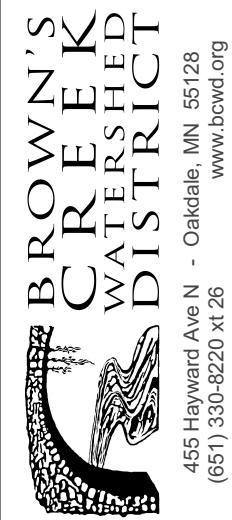
## Attachment B

### Rule 4.0 – LAKE, STREAM, AND WETLAND BUFFER MAINTENANCE REQUIREMENTS

[Irrelevant portions of Rule 4.0 omitted; subsections 4.4.2, 4.4.3 and/or 4.4.4 also should be deleted if inapplicable]

#### 4.4 Limitations in Buffer Zones.

\* \* \*

4.4.2 Lake and Wetland Buffers; Streamside Zone of Stream Buffer. The following activities are prohibited within a lake or wetland buffer, and within the streamside zone of a stream buffer:

- (a) Creating impervious cover.
- (b) Excavating fill or placing fill or debris, except for temporary placement of fill or debris pursuant to duly-permitted work in the associated watercourse, in compliance with all conditions of the permit, and in compliance with section 4.6.
- (c) Altering vegetation, except for (i) vegetative enhancements, as approved in writing by staff; and (ii) the removal of invasive exotic species or of trees for disease control or revegetation. A tree larger than six inches in diameter at a point two feet above the ground may be removed only on written authorization from District staff on a determination that the function of the buffer will not be diminished.
- (d) Applying phosphorus-containing fertilizers, except on written authorization from District staff on a determination that phosphorus application is appropriate and will not injure the waterbody.
- (e) Locating roads or utilities, except pursuant to a crossing of the associated watercourse in accordance with section 4.7. Structures and appurtenances associated with the road or utility shall not be located within the streamside zone unless no feasible alternative exists. Outlet, flood control and stormwater treatment facilities may be located within the zone if so approved under Rule 2.0, except that a stormwater basin is not permitted:
  - (i) within the streamside zone of a stream buffer; or
  - (ii) within the buffer of a groundwater-dependent natural resource, unless the basin bottom is at least three feet above the seasonal high water table, bedrock or other impeding layer and the basin and associated facilities are designed and maintained to infiltrate the two-year, 24-hour precipitation event.

Template BCWD/08  
Declaration – Stream Buffer

1

**4.5 Shoreline and Bank Stabilization.** A measure to stabilize a shoreline or bank otherwise regulated under Rule 5.0 must comply with sub-section 4.6.1 but otherwise is excepted from the prohibitions of section 4.4.

#### 4.6 Temporary Alterations.

- 4.6.1 Compliance with Rule 3.0 is required, irrespective of the area or volume of earth to be disturbed.
- 4.6.2 Buffer zones and the location and extent of vegetation disturbance shall be delineated on the erosion control plan.
- 4.6.3 Alterations must be designed and conducted to ensure only the smallest amount of disturbed ground is exposed for the shortest time possible. Mulches or similar materials must be used for temporary soil coverage and permanent native vegetation established as soon as possible.
- 4.6.4 Fill or excavated material shall not be placed to create an unstable slope.
- 4.6.5 When construction, land disturbance, fill or excavation activity occurs within the outer zone, the boundary between the outer and middle zones shall be demarcated with siltation or other fencing to prevent disturbance of vegetation within the middle zone. When construction, land disturbance, fill or excavation activity occurs within the middle zone, the boundary between the middle and streamside zones shall be demarcated with siltation or other fencing to prevent disturbance of vegetation within the streamside zone.

#### 4.7 Roads and Utilities.

- 4.7.1 A structure, impervious cover or right-of-way maintained permanently in conjunction with a crossing of the waterbody or wetland shall minimize the area of permanent vegetative disturbance to the degree feasible. Minimization includes, but is not limited to, approach roads and rights-of-way that are perpendicular to the crossing and of a minimum width consistent with use and maintenance access needs.
- 4.7.2 All work shall be in accordance with section 4.6.

#### 4.8 Exceptions.

- 4.8.1 An impervious surface, road or utility in existence on May 1, 2007, (for wetlands and groundwater-dependent natural resources other than public waters) or January 1, 2000 (for other waters), its maintenance, and maintenance of its existing right-of-way are excepted from the operation of Rule 4.0. Any increase in area or reconstruction of a surface, road or utility excepted under this sub-section is subject to the Rule. A public road or a utility may be located within a buffer zone on a

Template BCWD/08  
Declaration – Stream Buffer

2

finding that avoiding the buffer is infeasible and in accordance with the standards of section 4.7.

- 4.8.2 Access to a waterbody or wetland for a lawful private or public use of the resource may be created and maintained. All access surfaces within the buffer zone must be pervious and permanent vegetative disturbance shall be limited to that necessary for access in light of the nature and extent of the permitted use. No facility, other than a footpath or a facility accessory to a permitted use of the waterbody or wetland and required by its nature to be adjacent to the water, may be located within the streamside zone.

## NOTE:

This is a copy of the language from Attachment B from the recorded Buffer Declaration for Heifort Hills. This is for reference only and questions regarding statements and content contained within should be directed to the Brown's Creek Watershed District.

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[www.mnwcd.org](http://www.mnwcd.org)



Plan created by:

|                 |  |
|-----------------|--|
| Project Address | Heifort Hills HOA<br>Stillwater, MN 55082      |
| Project Manager | Bryan Pynn<br>Washington Conservation District |

**BROWN'S CREEK WATERSHED DISTRICT**  
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|               |                                   |
|---------------|-----------------------------------|
| Project Title | Heifort Hills Buffer Mgmt         |
| Sheet Title   | Attachment B - Buffer Declaration |
| Date          | 06/28/2021                        |

CAD File Name: Heifort Mgmt Plan.wks

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